GENERAL

- 1. ALL MATERIALS AND WORKMANSHIP SHALL CONFORM TO THE LATEST EDITION OF ALL RELEVANT CODES AND STANDARDS.
- 2. CONFORM TO OWNER'S GENERAL SPECIFICATIONS INCLUDING ALL SAFETY REQUIREMENTS.
- 3. SITE VERIFY ALL DIMENSIONS AND LEVELS.
- 4. KEEP THE SITE THROUGHOUT THE WORK AREA IN A CLEAN AND ORDERLY CONDITION AT ALL TIMES TO THE SATISFACTION OF THE OWNER.
- 5. ALL STRUCTURAL DRAWINGS ARE TO BE READ IN CONJUNCTION WITH OTHER CONSULTANTS DRAWINGS.
- 6. THE PROPOSED REPAIRS TO THE FOUNDATION OF THE SALT STORAGE DOME ARE A SHORT TERM SERVICEABILITY STOP GAP REPAIR WHILE THE MUNICIPALITY OF CLARINGTON IMPLEMENTS LONG TERM CAPITAL PLANNING FOR REPLACEMENT OF THE STRUCTURE. FURTHER CRACKS AND SPALLING SHOULD BE ANTICIPATED AFTER THE REPAIRS HAVE BEEN COMPLETED.
- 7. THE REMEDIAL REPAIRS WERE COMPLETED UTILIZING EXISTING INFORMATION ON REFERENCE DRAWINGS DRAWINGS BY SUB-CON ENGINEERING CORPORATION PROFESSIONAL ENGINEERS DATED JUNE 20, 1985.

CONCRETE

1. CONCRETE CONSTRUCTION SHALL CONFORM TO THE LATEST EDITION OF CAN/CSA-A23.1 AND CAN/CSA-A23.3 WITH THE FOLLOWING PROVISION:

LOCATION	DESIGN STRENGTH (28 DAYS)	SLUMP	EXPOSURE CLASS
ALL EXTERIOR REINFORCED CONCRETE (STAIRS & RETAINING WALLS)	35 MPa U.N.O.	80± 30	C-1

- 2. NO ADDITIONAL WATER SHALL BE ADDED AT THE JOB SITE. CONCRETE WHICH HAS BEEN WATERED OR DOES NOT MEET SPECIFICATIONS SHALL BE REJECTED.
- 3. DURING WINTER WEATHER BELOW 5 C PROVIDE TEMPORARY HEATING OF CONCRETE IN ACCORDANCE WITH THE REQUIREMENTS OF CSA A23.1, LATEST EDITION.
- STRUCTURAL GROUT SHALL BE NON-SHRINK, NON METALLIC M-BED STANDARD PREMIX BY SIKA OR APPROVED EQUAL.

CONCRETE REINFORCEMENT 1. THE CLEAR DISTANCE BETWEEN REINFORCING STEEL AND SURFACE OF CONCRETE

SHALL BE AS FOLLOWS UNLESS NOTED OTHERWISE.

LOCATION	CLEAR COVER
WALLS	50mm(2") AGAINST EARTH (20M BAR OR GREATER) 40mm(1½") AGAINST EARTH (15M BAR) 40mm (1½") AGAINST FORM (20M BAR OR GREATER) 25mm (1") AGAINST FORM (15M BAR)

- 2. DETAIL REINFORCING STEEL IN ACCORDANCE WITH "REINFORCING STEEL MANUAL OF STANDARD PRACTICE" LATEST EDITION.
- 3. REINFORCING BAR SPLICES FOR DEFORMED BARS:
- COLUMNS COMPRESSION LAP UNLESS NOTED WALLS – CLASS 'B' TENSION SPLICE UNLESS NOTED
- ALL OTHERS CLASS 'B' TENSION LAP UNLESS NOTED
- 4. ALL REINFORCING STEEL SHALL BE DEFORMED HARD GRADE BILLET STEEL CONFORMING TO CSA G30.18 GRADE 400.
- 5. WELDED STEEL WIRE FABRIC, PLAIN TYPE CONFORMING TO ASTM A1064/A1064M-17 IN FLAT SHEETS NOT ROLLED.
- 6. ALL CONCRETE REINFORCEMENT MUST BE PROPERLY CHAIRED WITH APPROVED BAR SUPPORTS.
- 7. PROVIDE CHAIRS, SPACER BARS, SUPPORT BARS AND OTHER ACCESSORIES TO SUPPORT REINFORCING IN ACCORDANCE WITH THE LATEST EDITIONS OF CSA A23.1 AND CSA A23.3 CHAIRS TO BE PLASTIC, PLASTIC TIPPED OR CONCRETE. ALL TIE WIRE, CHAIRS AND BAR SUPPORTS USED FOR COATED REINFORCING SHALL BE NON-METALLIC OR PROTECTED WITH ACCEPTABLE COATING.
- 9. CHAIRS SHALL BE SPACED AT 1200mm(4'-0")O.C. MAXIMUM.

DOME DESIGN LOADS

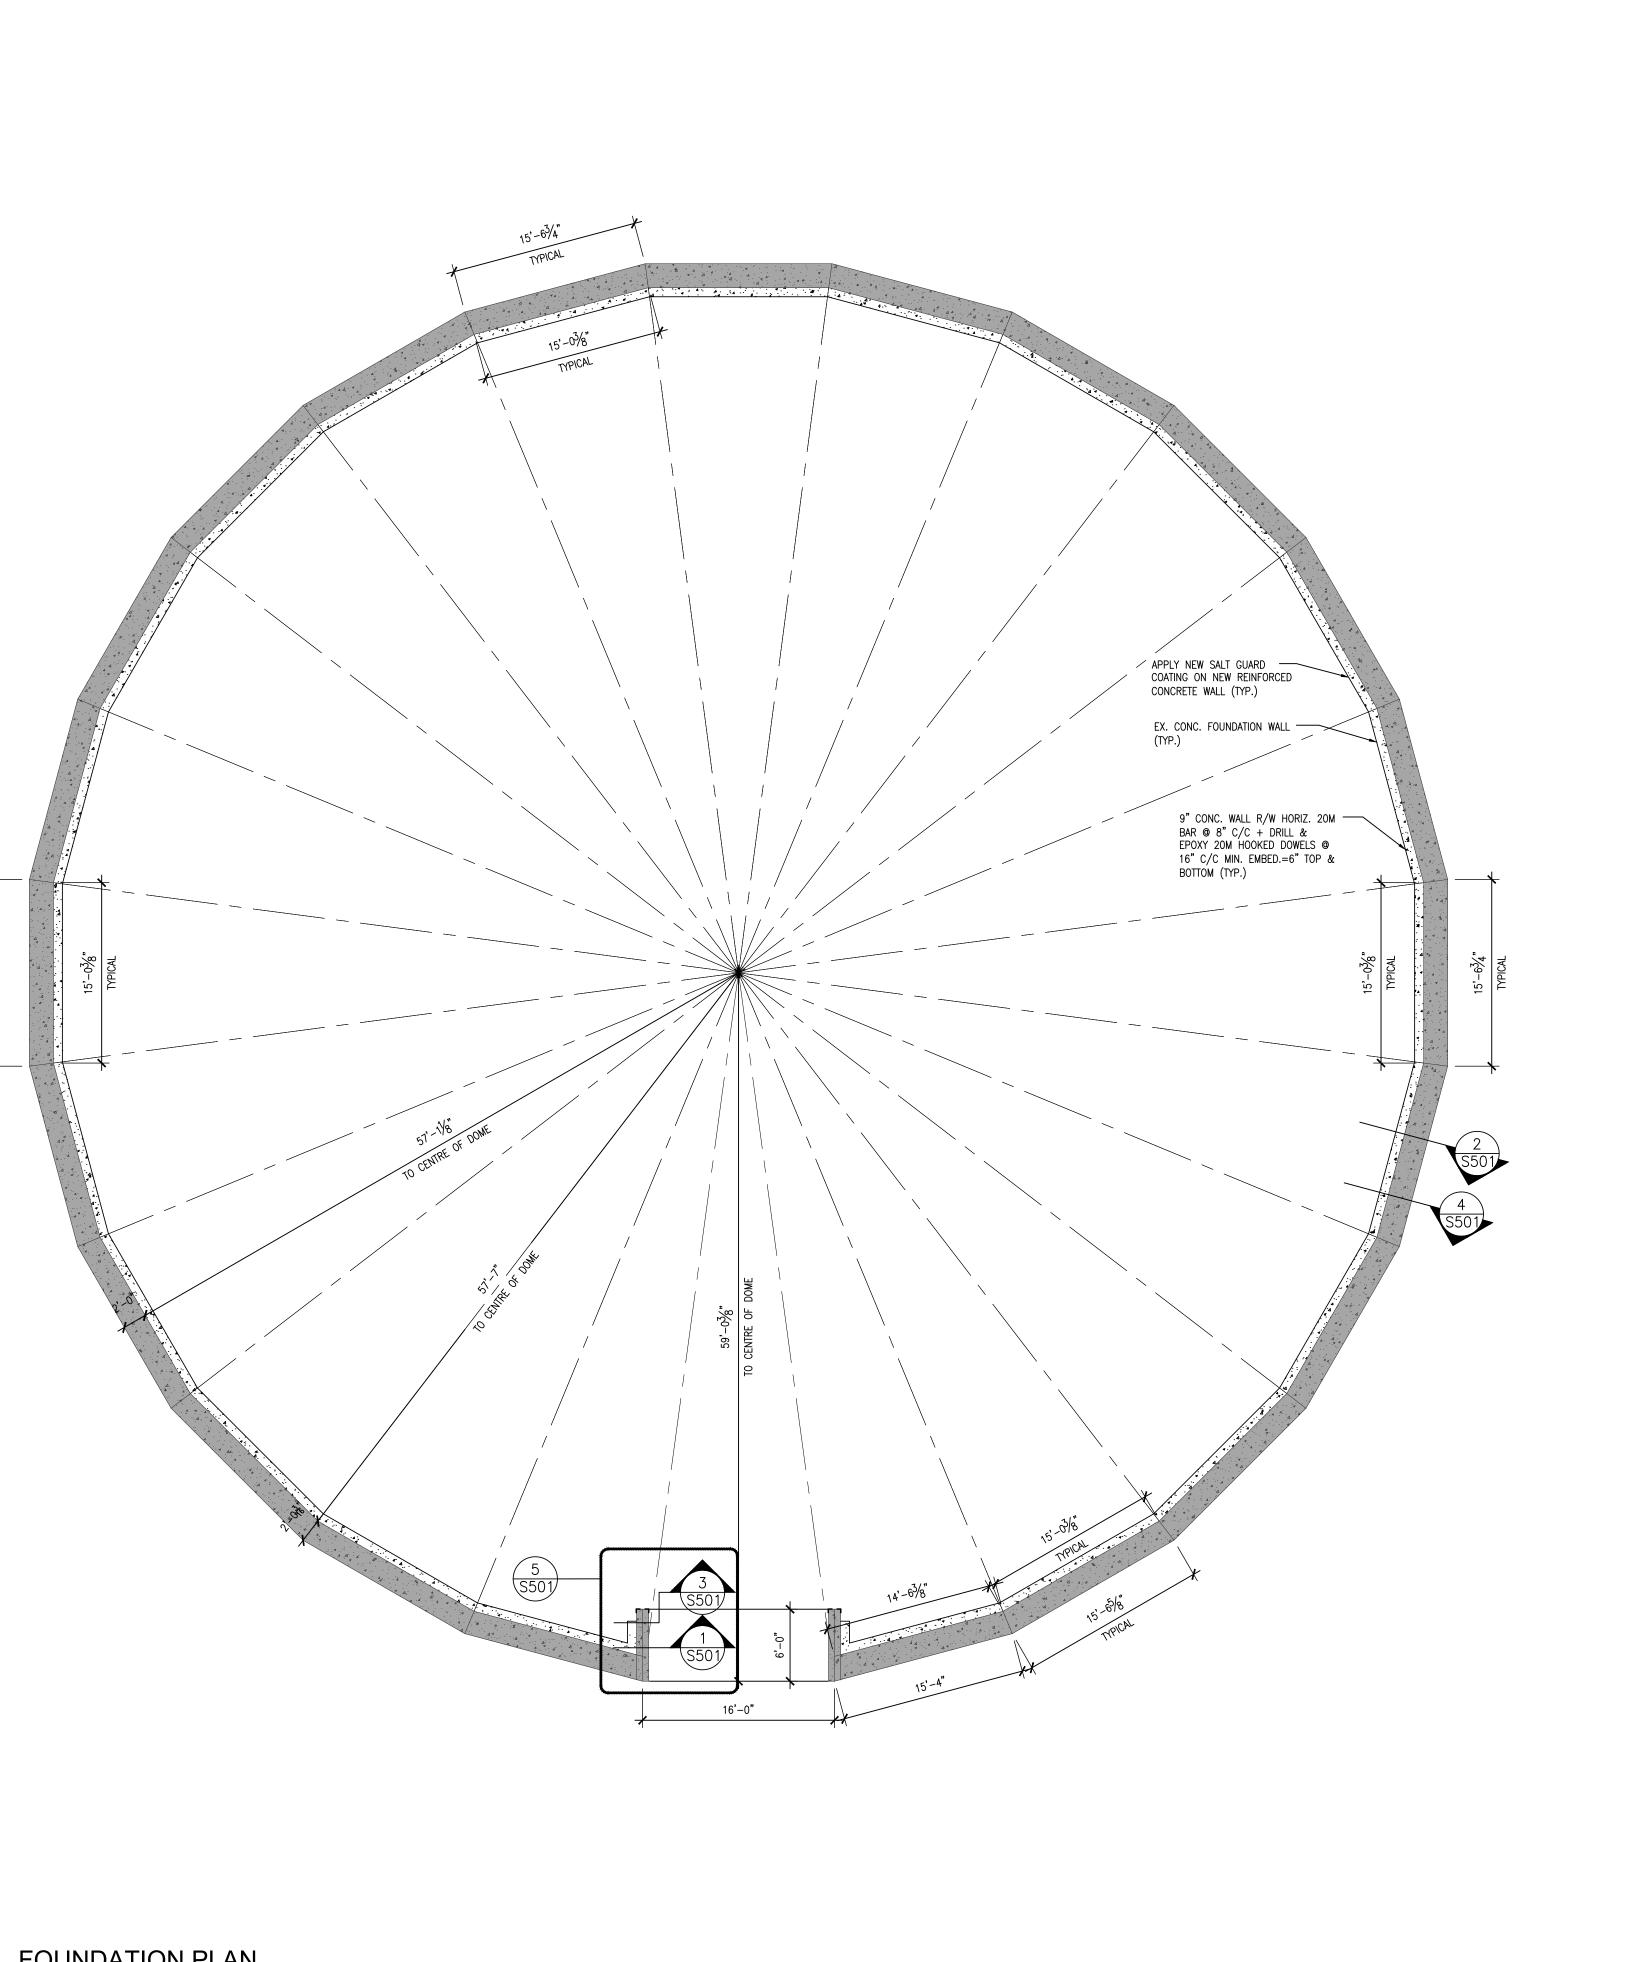
DEAD LOAD = 1.63 kPa

SNOW LOAD = 1.52 kPa

QUAN	ITITIES OF REF	PAIRS
REPAIR TYPE: HAIRLINE CRACK < 1/4" CRACK 1/4"-1/2" CRACK > 1/2" CRACK SPALL	= 60.0 LFT = 215.0 LFT = 145.0 LFT = 65.0 LFT = 110 SQFT	DETAIL 6/S501 6/S501 7/S501 7/S501 1/S501 & 2/S501
NOTE: CONTRACTOR TO SIT	E VERIFY ESTIMATED	QUANTITIES FOR REPAIRS



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ROJECT NO: 24069	DRAWING NO:	1
-mail: bba@bba-archeng.com	FILE:	
el: (905) 666-5252 ^F ax: (905) 666-5256	SCALE: 1/8"=1'-0"	
Guite 201 Vhitby, Ontario .1N 0G5	DATE: APRIL 2024	
Project Managers 250 Water Street	CHECKED BY:	INITIAL:
Architects Engineers	DRAWN BY:	% COMPLE

BBA

BARRY BRYAN

ASSOCIATES

STRUCTURAL NOTES AND FOUNDATION PLAN

DESIGN BY: BBA

DOC CONTROL: DATE:

% COMPLETE:

DRAWING:

2320 TAUNTON ROAD, HAMPTON, ON LOB 1J0 MUNICIPALITY OF CLARINGTON

EXISTING SAND STORAGE **CONCRETE WALL REPAIR**

PROJECT:

Copyf Upon Witho	REQUEST. REPRODUCTION OF DRA OUT THE PERMISSION OF THE CONS	ULTANT IS FORBIDDE	EN.
DRAWI AND S	NGS ARE NOT TO BE USED FOR CO EALED BY THE CONSULTANT.	NSTRUCTION UNTIL	SIGNED
NO.	ISSUES	DATE	BY
1	ISSUED FOR REVIEW	JUNE 07, 2024	BBA
2	ISSUED FOR TENDER	FEB 03, 2025	BBA

DO NOT SCALE THE DRAWINGS CHECK AND VERIFY ALL DIMENSIONS AT THE SITE.

